CITY OF NEPTUNE BEACH, FLORIDA BIDDING, SPECIFICATIONS, AND CONTRACT DOCUMENTS FOR

NEPTUNE BEACH SENIOR ACTIVITY CENTER PORCH AND EXTERIOR FINISHES CONB BID NO. 2023-01

To: All Bidders

From: Jason Lupson, City of Neptune Beach Project Manager

Subject: Addendum #3

Date: 03/27/2023

1. See attached question/answer response sheet.

ITB# 2023-01	Senior Activity Center Porch and Exterior Finishes
QUESTIONS	RESPONSES
 Sheet A1 has an area on the North end of the building labeled as "Existing Pond", Civil Sheet 6 of 9 indicates that this is a "Dry-Swale" with an Earthen Weir Outlet on the West side of the building, which appears to be part of the bid work – please clarify. 	Sheet A1 is provided for reference. Refer to civil and landscape plans for site work scope.
 Civil Sheet 6 of 9 call for "Existing Roof Drainage System to be Connected to Proposed Swale". During our site inspection, we did not see any existing (exterior) roof drainage, nor do we see any called for on the new addition - please clarify. 	There are existing downspouts that tie in under the structure. These are to be connected to the swale.
 During the site inspection we noted several pipes coming out of the ground on the East elevation that appear to be HVAC condensate drains, Please clarify of these are to remain as-is. 	Minor modifications should be anticipated around footers and structure as needed.
4. Assuming the 6 PVC pipes coming out of the ground on the east side of the building are the condensate lines for the existing AC are they to remain in that location or are we required relocate them outside of the new porch	These should be extended eastward, directly outside of the porch footprint.
5. The antenna on the roof has a power cord running over the edge of the roof to an outlet located on the side wall once the new roof is installed what is the plan for getting power to the antenna	The antenna will need to be hard-wired into the building's electrical system by a certified electrician.
6. Can the footing types be labeled/identified on the foundation plan – Sheet A4	See attached.
Sheet A8 states fixtures "selected by owner" can you please clarify if that includes the owner purchasing the fixtures	The owner will purchase the fixtures. The contractor will install them.
8. Sheet L-2.1 shows the 89 rock going up to the building on the west side is the intention to leave the condensers and fill around them or disconnect the condensers and re-install with the stone underneath the units	Reinstall stone under the units.
9. The form of Bid (attached) is broken down into 75 individual line items, however, there seems to be some overlap. For example, Item #61 says to "Furnish all equipment, materials, and Labor to Complete Porch, Roof, ADA Ramps, and stairs", however lines 4 thru 60 above breakout all of the individual pieces and parts that go into Item 61. Is the intention to show material only costs on Items 4 thru 60 and Equipment/Labor in Item 61?	Individual material costs are requested for any modifications in the field. The split between material costs and equipment/labor as described in the question is acceptable.

NEW DECK-— 1,614 Sq. Ft. NEW H.C. RAMPS --------- 474 Sq. Ft.

TYPE OF CONSTRUCTION

TYPE VB

PROJECT IS LOCATED EAST OF 1-95 WIND-BORNE DEBRIS PROTECTION IS REQUIRED

WIND ZONE INFORMATION

THIS STRUCTURE HAS BEEN DESIGNED IN ACCORDANCE WITH, & MEETS THE REQUIREMENTS OF THE FLORIDA BUILDING CODE 2020 7th EDITION

1. BASIC WIND SPEED (3 SECOND GUSTS) --- 130 M.P.H. 2. WIND IMPORTANCE FACTOR — 1.0

4. INTERNAL PRESSURE COEFFICIENT

5. COMPONENT & CLADDING WIND LOADS Lbs./Sq.FT.

HEIGHT AND EXPOSURE ADJUSTMENT COEFFICIENTS = 100

HEIGHI	AND		JRE AL)JUS	11 1	ENI CC			=	1.00	
EFFECTIVE WIND AREA Ft. Sq.											
	10		2Ø			50		100		0	
ROOF											
1	10.5	-25.9	10.0	-25.2		10.0	-24.4	10.0		-23.7	
2 \$ 3	10.5	-43.5	10.0	-38	8.	10.0	-32.7	10.0		-28.1	
WALL											
4	25,9	-28.1	24.7	-26.9		23.2	-25.4	22.0		-24.2	
5	25.9	-34.7	24.7	-32.4		23.2	-29.3	22.0		-26.9	
ROOF OVERHANG			100		20		50			100	
		-37.3			-36.7	-35.2	-35.2		-35.1		
			-61.5		-48.3		-30.	-30.8		-17.6	

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σ	(10)	(2)	(1)	D

NOTES:

1. FOR EFFECTIVE AREAS BETWEEN THOSE GIVEN ABOVE THE LOAD MAY BE INTERPOLATED BY THE DESIGNER, OTHERWISE USE THE LOAD ASSOCIATED WITH THE LOWER EFFECTIVE AREA.

2. SEE FIGURES FOR LOCATION OF ZONES.

3. PLUS AND MINUS SIGNS SIGNIFY PRESSURE ACTING TOWARD AND AWAY FROM THE BUILDING SURFACES.

CODE ANALYSIS

THIS STRUCTURE HAS BEEN DESIGNED IN ACCORDANCE

WITH, & MEETS THE REQUIREMENTS OF:

BUILDING - FLORIDA BUILDING CODE, BUILDING 2020 7th EDITION PLUMBING - FLORIDA BUILDING CODE, PLUMBING 2020 7th EDITION


MECHANICAL - FLORIDA BUILDING CODE, MECHANICAL 2020 7th EDITION

LIFE SAFETY - NATIONAL FIRE PREVENTION ASSOC. CODE, LATEST EDITION FIRE CODE - FLORIDA FIRE PREVENTION CODE 1th EDITION

HANDI-CAP CODE - FLORIDA BUILDING CODE, CHAPTER 11 - ACCESSIBILITY, 2020 7th EDITION ACCESSIBILITY CODE - FLORIDA BUILDING CODE, CHAPTER 11 - ACCESSIBILITY, 2020 7th EDITION

ENERGY CODE - FLORIDA BUILDING CODE, ENERGY CONSERVATION, 2020 7th EDITION

NATIONAL ELECTRIC CODE CURRENT EDITION

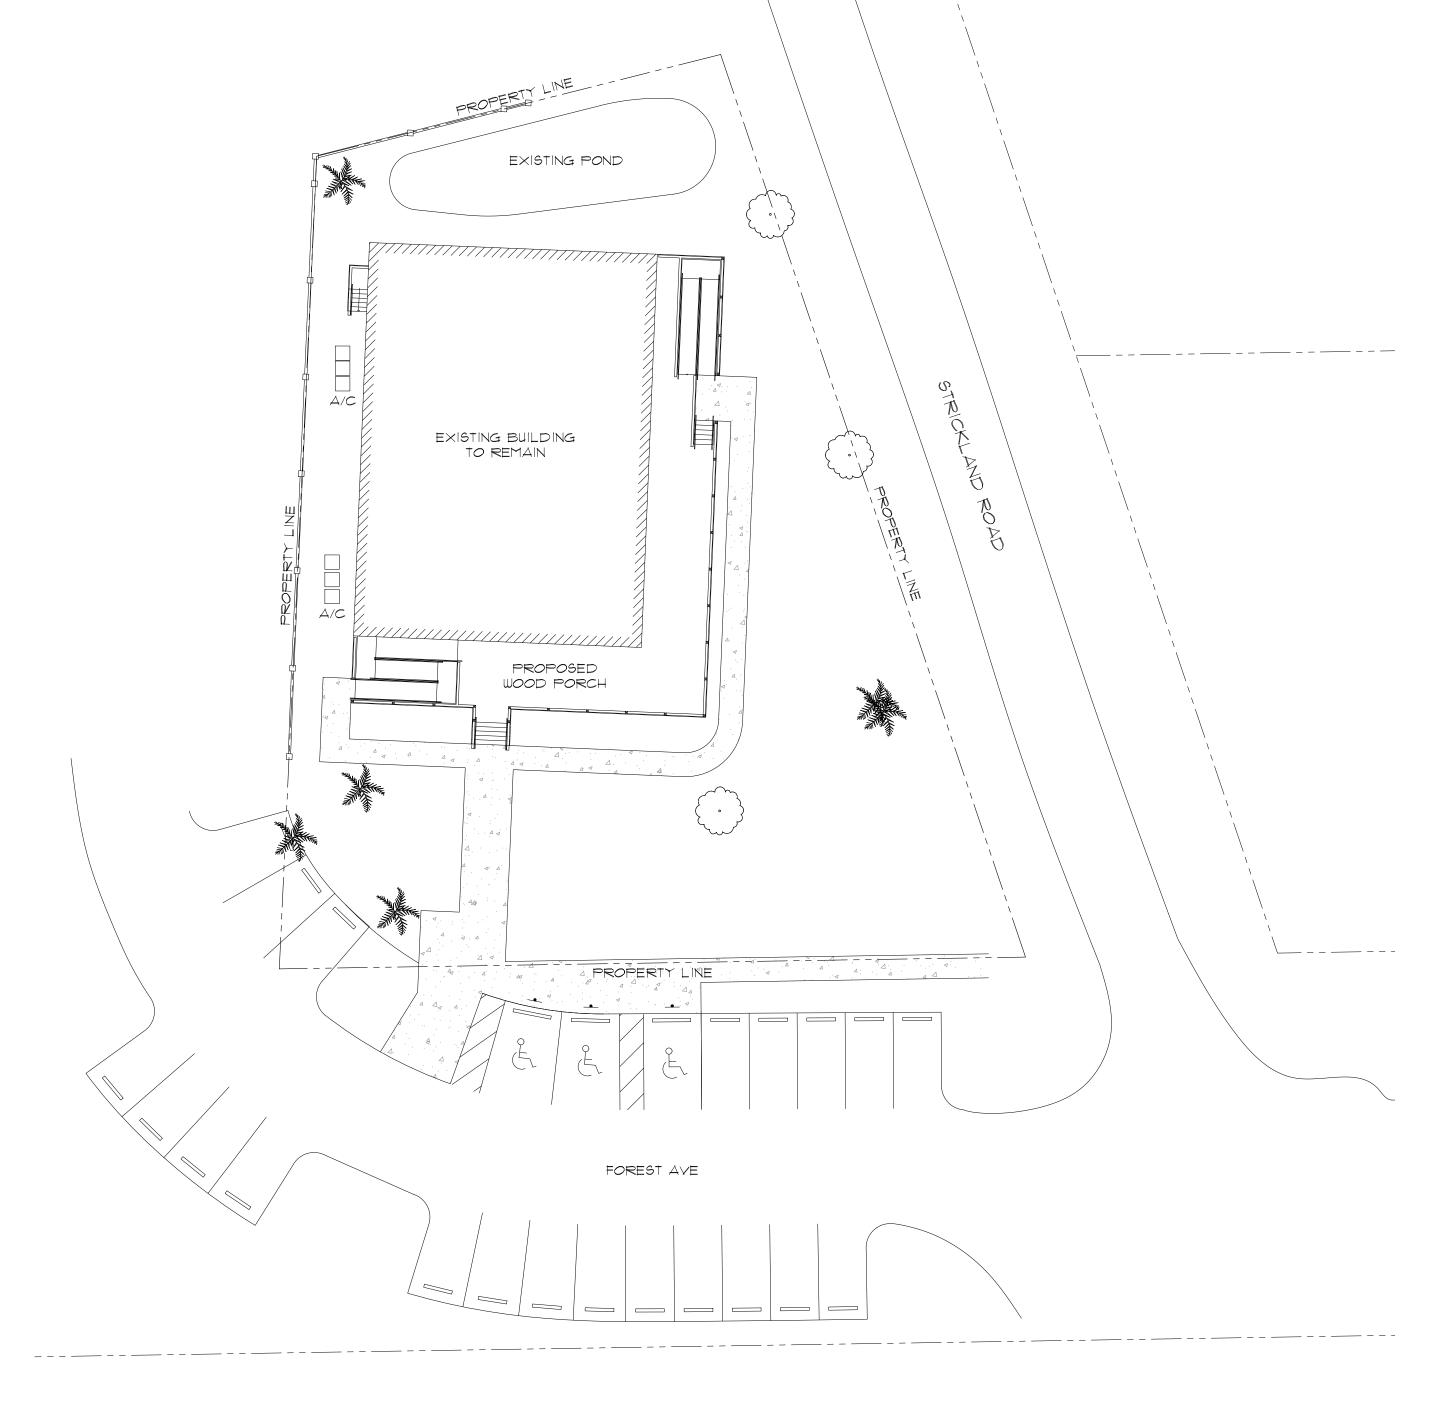



Neptune Beach Senior Community Center Neptune Beach, Florida

INDEX OF DRAWINGS

AI CODE INFORMATION AND SHEET INDEX

A2 FLOOR PLAN A3 BUILDING ELEVATIONS

A4 FOUNDATION PLAN

A5 FLOOR FRAMING PLAN

A6 ROOF FRAMING PLAN AT BUILDING SECTIONS AND DETAILS

AS ELECTRICAL PLAN

STRUCTURAL NOTES

(FL. BLDG. CODE 2020)

1. DESIGN LOADS:

A. ROOF LIVE LOADS -— 16 p.s.f. B. FLOOR LIVE LOADS-- 40 p.s.f.

C. WIND LOADS-

2. MATERIAL

A. CONCRETE: DESIGN AND CONSTRUCTED PER A.C.I. 318-83

COMPRESSIVE STRENGTH @ 28 DAYS SLAB ----— 2,500 P.S.I.

C.M.U. FILLED CELLS & BEAMS - 2,500 P.S.I.

B. REINFORCING STEEL: CONFORM TO ASTM A-615 GAGE 60 C. STRUCTURAL STEEL: DESIGN PER CURRENT ADDITION

OF A.I.S.C. 1. SHAPES AND PLATES CONFORM TO ASTM A-36

2. WELDING CONFORM TO "AWS D1.1, STRUCTURAL WELDING CODE"

3. ANCHOR BOLTS AND STEEL TO WOOD SHALL CONFORM TO ASTM A-307

4. WELDED CONNECTIONS NOT SHOWN ON DRAWING SHALL HAVE ALL CONTACTING STEEL SURFACES CONTINUOUS WELDED WITH SUFFICIENT WELD TO FULLY DEVELOP THE THINNER MATERIAL.

D. FRAMING LUMBER: SOUTHERN PINE PER N.F.P.A., NATIONAL DESIGN SPECS. FOR WOOD CONSTRUCTION.

1. SAWN LUMBER 2x4 THRU 2x12 SHALL BE SOUTHERN PINE

2. INTERIOR WALL STUDS SHALL BE SPRUCE-PINE-FIR NO.2

3. LYL BEAMS SHALL BE SOUTHERN PINE F6=2400 P.S.I. 4. SAWN LUMBER 4x4 AND LARGER SHALL BE SOUTHERN PINE NO. 1 @ 19% M.C.

E. WOOD FLOOR & ROOF TRUSSES: DESIGN BY THE MANU-FACTURER TO SUPPORT DEAD, WIND AND LIVE LOADS.

1. MANUFACTURE SHALL SUBMIT ERECTION DRAWINGS FOR REVIEW BEFORE FABRICATING TRUSSES.

2. ERECTION DRAWINGS SHALL SHOW ALL LATERAL AND DIAGONAL BRACING AS REQUIRED IN THE TRUSS SYSTEM 3. TRUSS TO TRUSS CONNECTIONS SHALL BE DESIGNED BY

F. PLYWOOD ROOF AND WALL SHEATHING:

CONFORM TO THE AMERICAN PLYWOOD ASSOC. STANDARDS AND SHALL BE AP C-D INT. WITH EXTERIOR GLUE (CDX) MIN.

G. CONCRETE MASONRY UNITS: CONFORM TO ASTM C-90. MORTAR SHALL BE TYPE M OR S.

H. WOOD FRAMING ANCHORS AND HURRICANE TIE CLIPS

SHALL BE "GO-BOLTS" OR EQUAL.

4. CONCRETE MASONRY UNITS:

A. ALL C.M.U. SHALL HAVE #5 BAR VERTICAL WITH CELL FILLED WITH CONCRETE AS SHOWN ON DRAWINGS.

B. ALL C.M.U. SHALL HAVE HORIZONTAL JOINT REINFORCING SPACED 16" O.C. VERTICAL. REINFORCING SHALL BE FABRICATED FROM 9 GUAGE GALVANIZED WIRE.

5. CONTRACTOR SHALL BE RESPONSIBLE FOR ALL TEMP. BRACING UNTIL THE ENTIRE STRUCTURE IS PLUMB AND SECURED IN PLACE.

6. SHEATHING NAILING:

A. ROOF SHEATHING SHALL BE NAILED AS FOLLOWS:

8d RING SHANK NAILS 8d NAILS @ 6" O.C. AT PANEL EDGES.

8d NAILS @ 9" O.C. AT ALL INTERMEDIATE SUPPORTS.

8d NAILS @ 4" O.C. AT ALL SUPPORTS WITHIN 4'-0" OF EDGES.

B. PORCH CEILING OR SUB CEILING WITH RING SHANK NAILS: 8d NAILS @ 4" O.C. AT PANEL EDGES.

8d NAILS @ 8" O.C. AT ALL INTERMEDIATE SUPPORTS.

C. ALL EXTERIOR WALLS BETWEEN OPENINGS AND AT CORNERS SHALL BE SHEAR WALL SEGMENTS.

PLY-WOOD NAILING TO BE: 8d NAILS @ 6" O.C. EACH SHEAR WALL SEGMENT SHOULD HAVE 1/2 Ø THREADED ROD WITHIN 8" OF SHEAR WALL.

7. C.M.U. WALL OPENING HEADS, JAMBS, AND WINDOW SILLS SHALL BE 2x6 MIN. P.T. WITH 1/4" DIA. x 3.1/4" LONG "TAPCONS" @ 18" O.C.

8. ALL EXTERIOR WINDOWS AND DOORS SHALL MEET 130 M.P.H. WIND SPEED. WIND BORNE DEBRIS PROTECTION REQUIRED: IMPACT RESISTANT WINDOWS OR SHUTTERS BY ARCHITECT OR CONTRACTOR.

File: NEPTUNE

SHEET

Date: 4.29.22

Scale: AS NOTED

Drawn: MURPHY

PORCH

NEW

9208

FLORIDA COMMUNIT PORCH BEACH, NEW BEACH NEPTUNE

Date: 4.29.22 Scale: AS NOTED

Drawn: MURPHY

SHEET

File: NEPTUNE

Date: 4.29.22

Scale: AS NOTED


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File: NEPTUNE

SHEET

SHEET



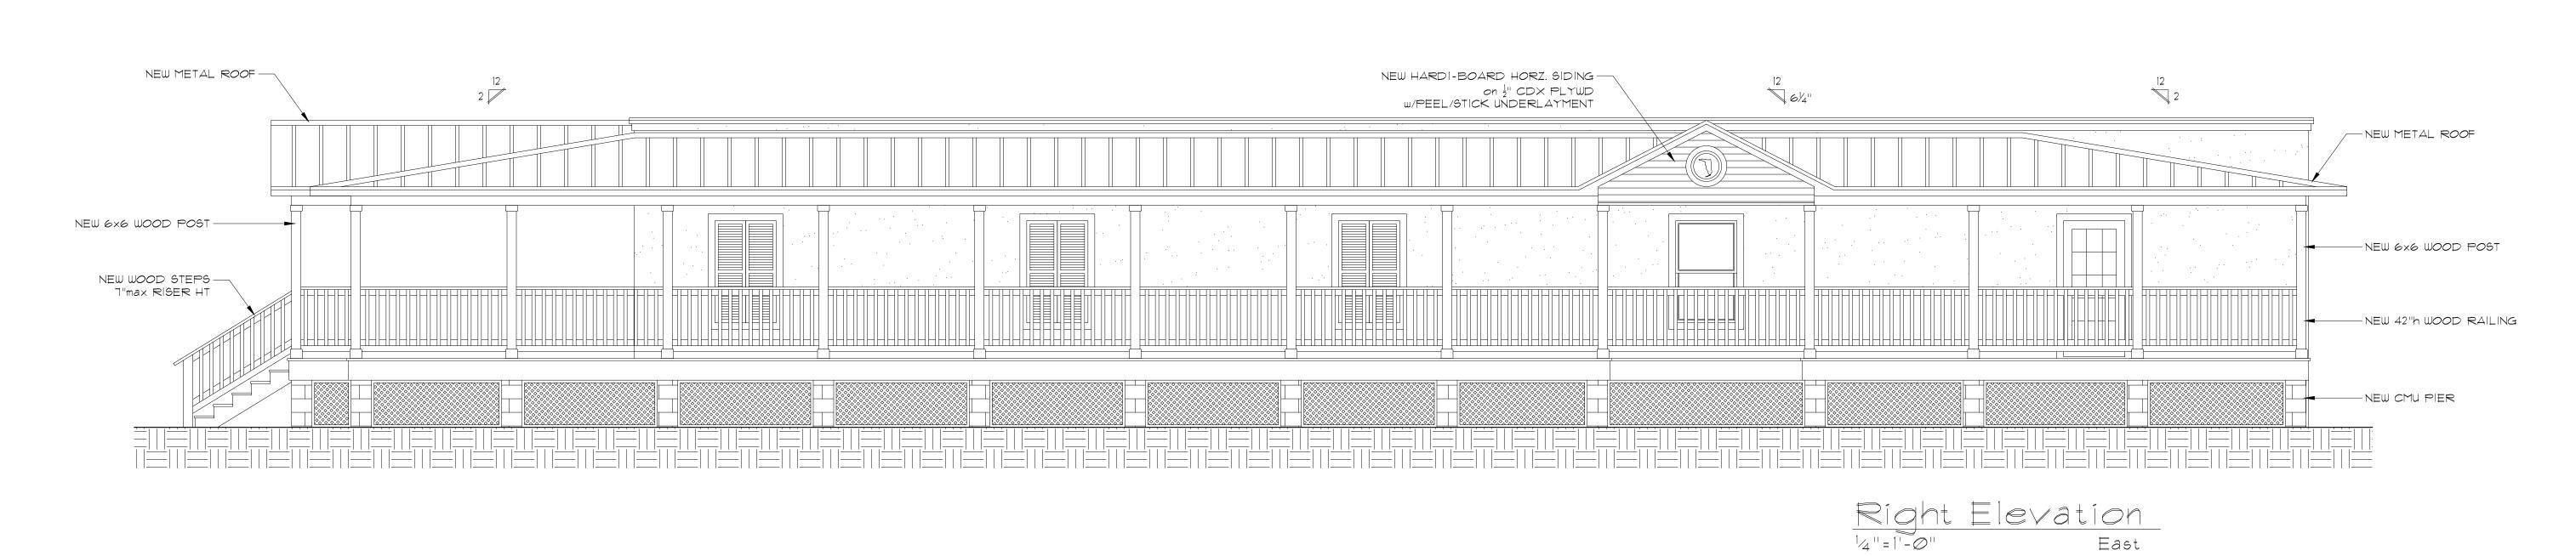

A R C H I T E C T 32 CORDOVA ST., ST. AUGUSTINE, FLORIDA 824-9508

NEPTUNE BEACH, FLORIDA


NEPTUNE BEACH, FLORIDA

Date: 4.29.22

Scale: AS NOTED


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File: NEPTUNE

SHEET

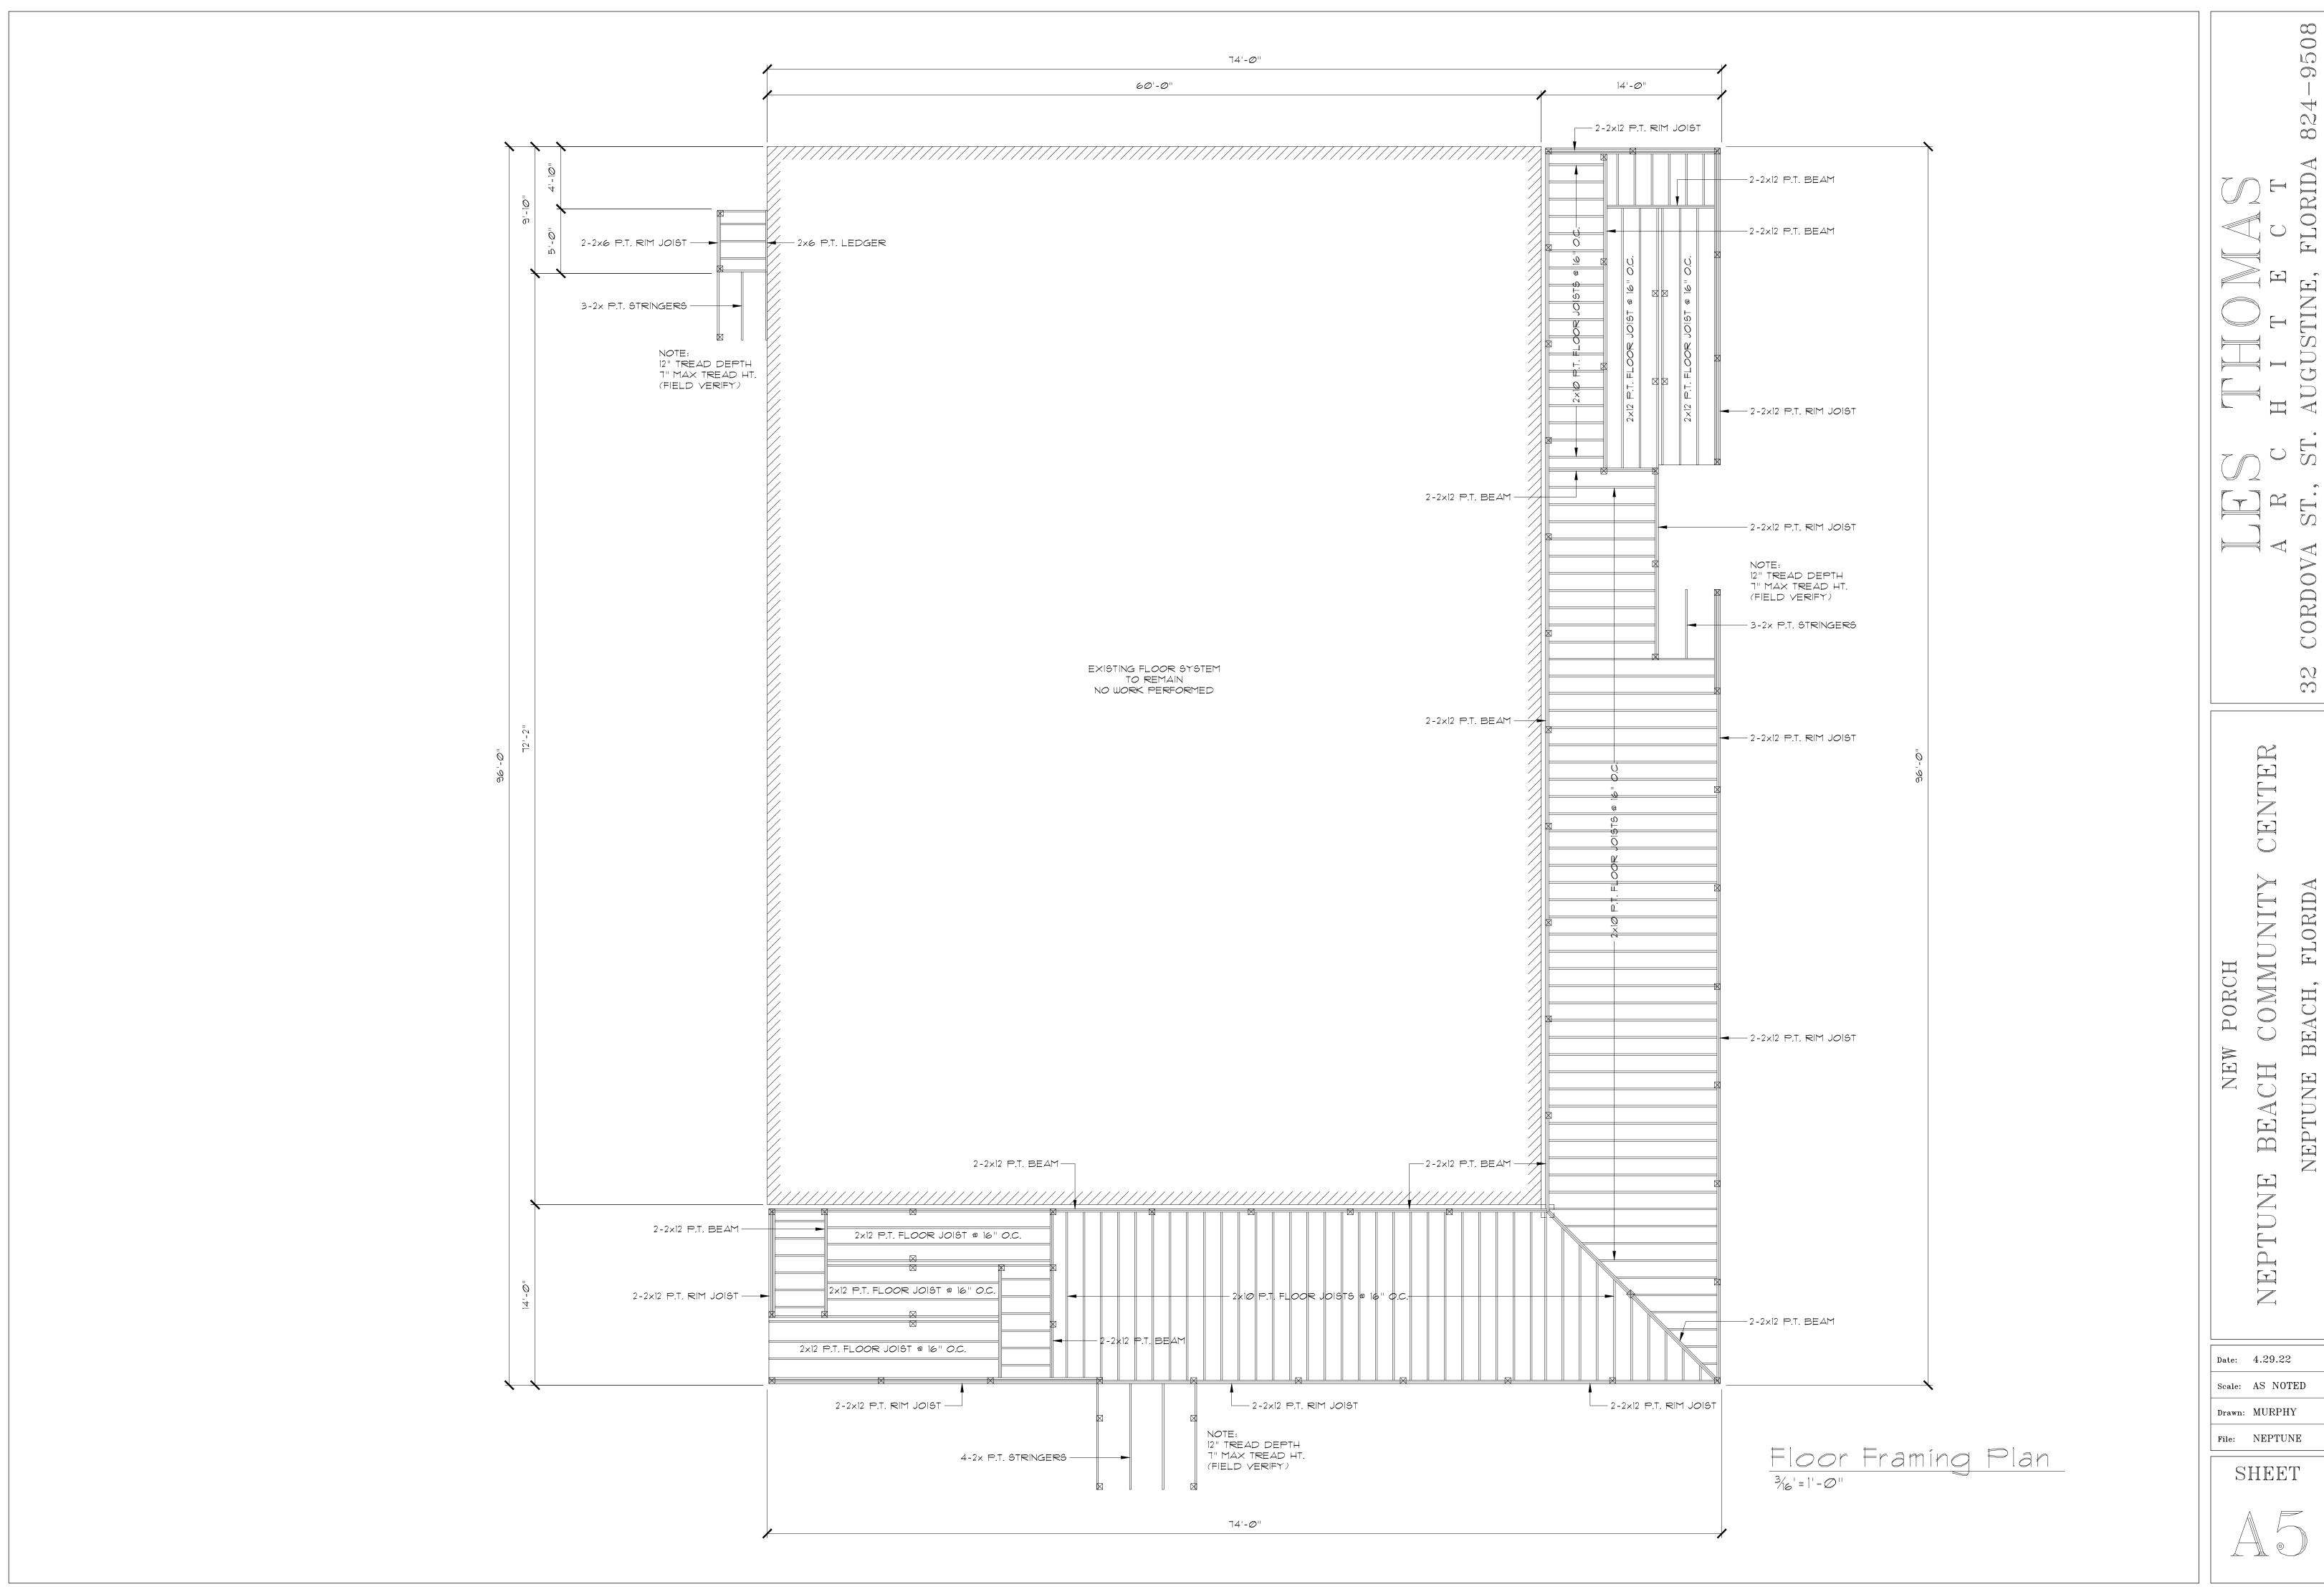

8

NEPTUNE

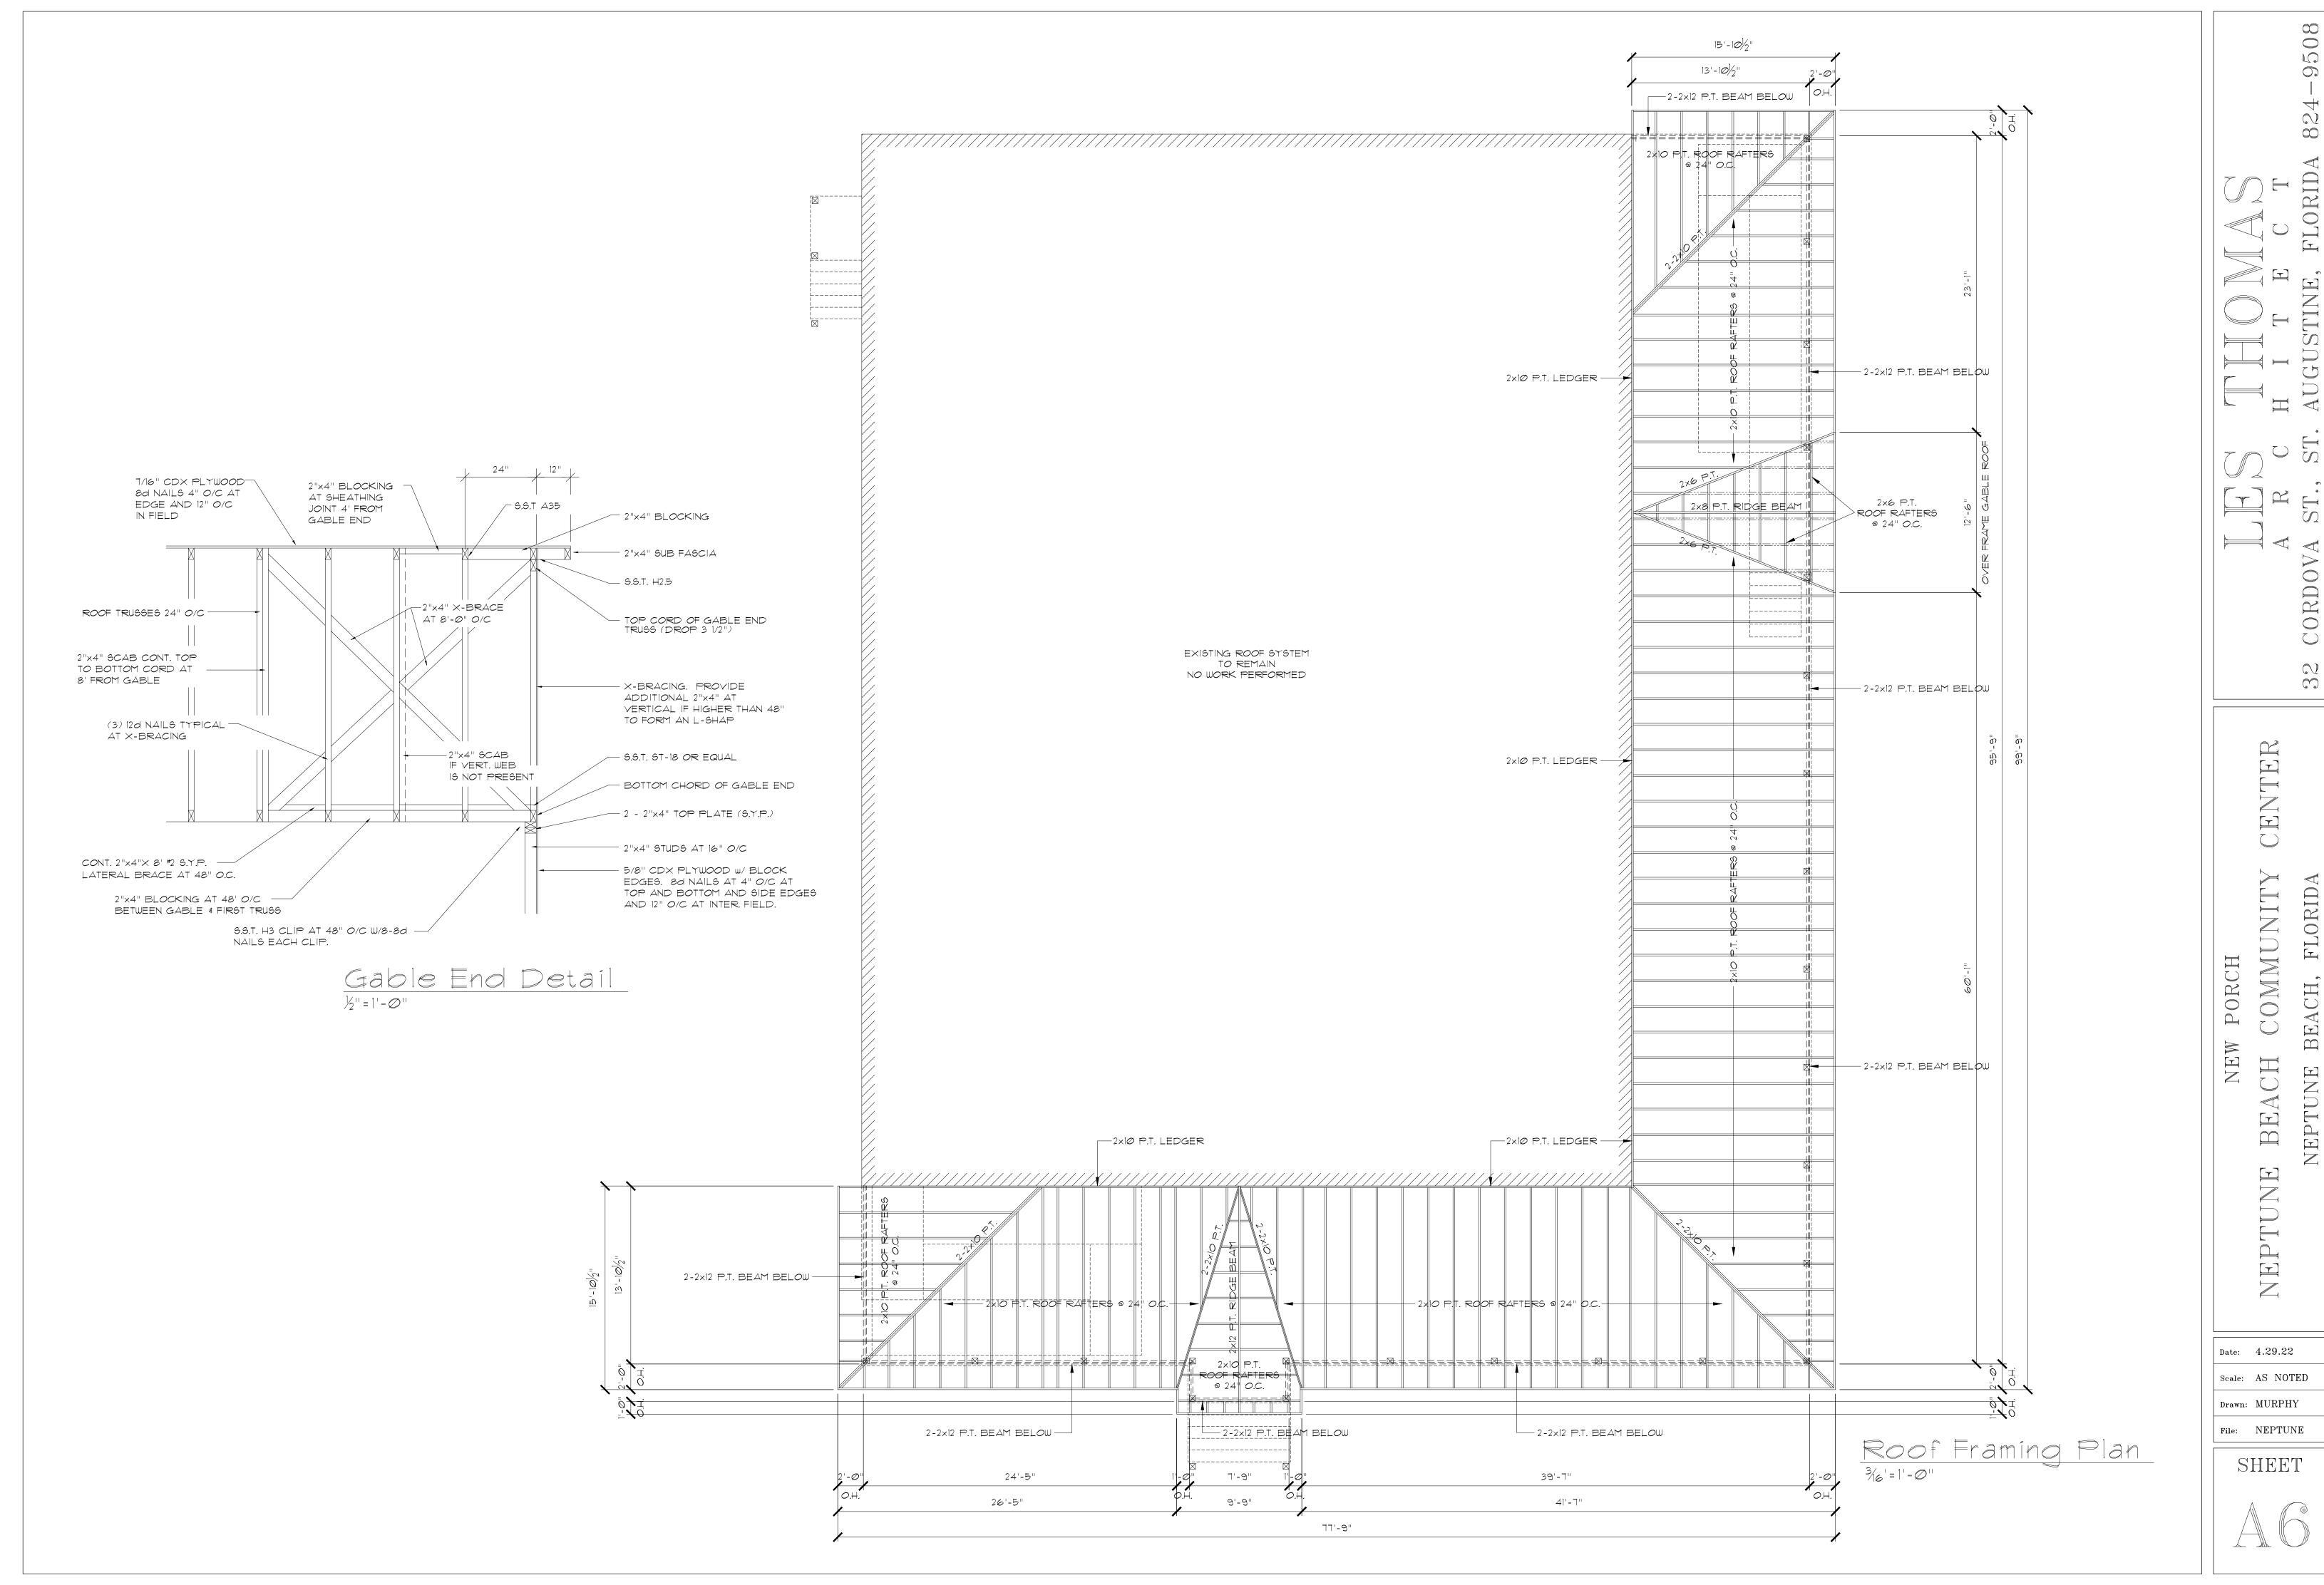

PEEL AND STICK UNDERLAYMENT

2'-Ø"

-P.T. 6x6 WOOD POST

-P.T. 6×6 WOOD POST

__2-2×12 P.T. WOOD BEAM

-SIMPSON COIL STRAP

EA. PIER, EA. RIM JOIST

w/2-½" GALV or S.S. THRU BOLTS w/NUT & WASHER

-GRADE VARIES

TYPICAL

TYPICAL

TREK DECK BOARDS

P.T. 2×12—

P.T. 2×10 FLOOR JOISTS @ 16" O.C. w/SIMPSON HANGERS EACH END

8×8×12 CMU w/#5 BARS -

CONC. FILL EA. CELL,

w/2-#5 BARS EA. WAY

18" LAP #5 REBAR

VERT. EA. CELL

FROM FOOTING

CLÉAN COMPACTED / TERMITE TREATED FILL

(CONC. 3000 P.S.I.)

16"x20"x12"d CONC. FTG.

Ramp Section

3/4"=1'-0"

— 2×1∅ RAFTERS @ 24" O.C.


-SIMPSON SDWC15600 SCREW EA. TRUSS TO DBL PLATE

- METAL DRIP EDGE

— 2× FASCIA


/- ½" T-111 PLYWD

File: NEPTUNE SHEET

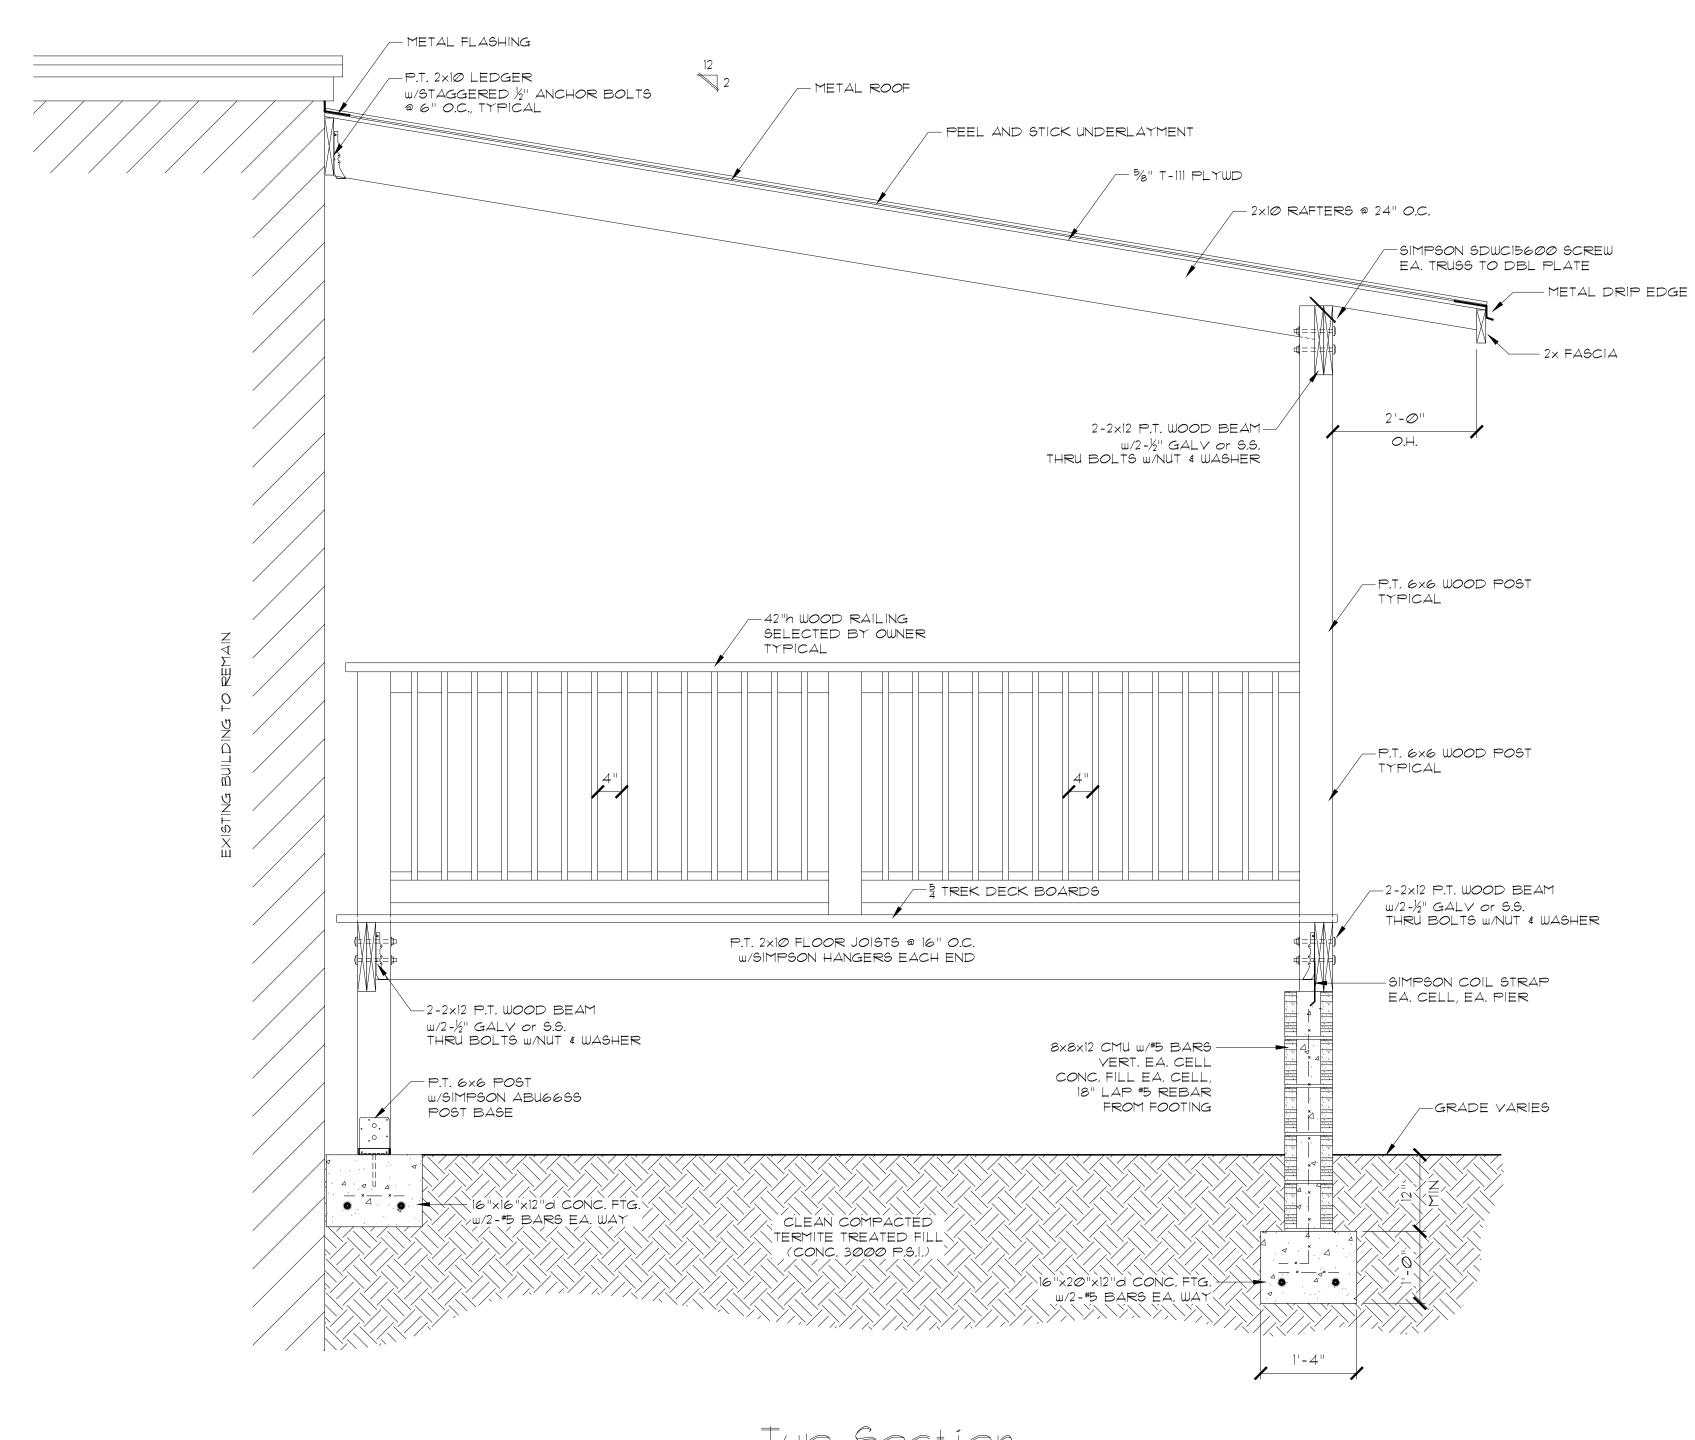

Typ Section

3/4"=1'-0"

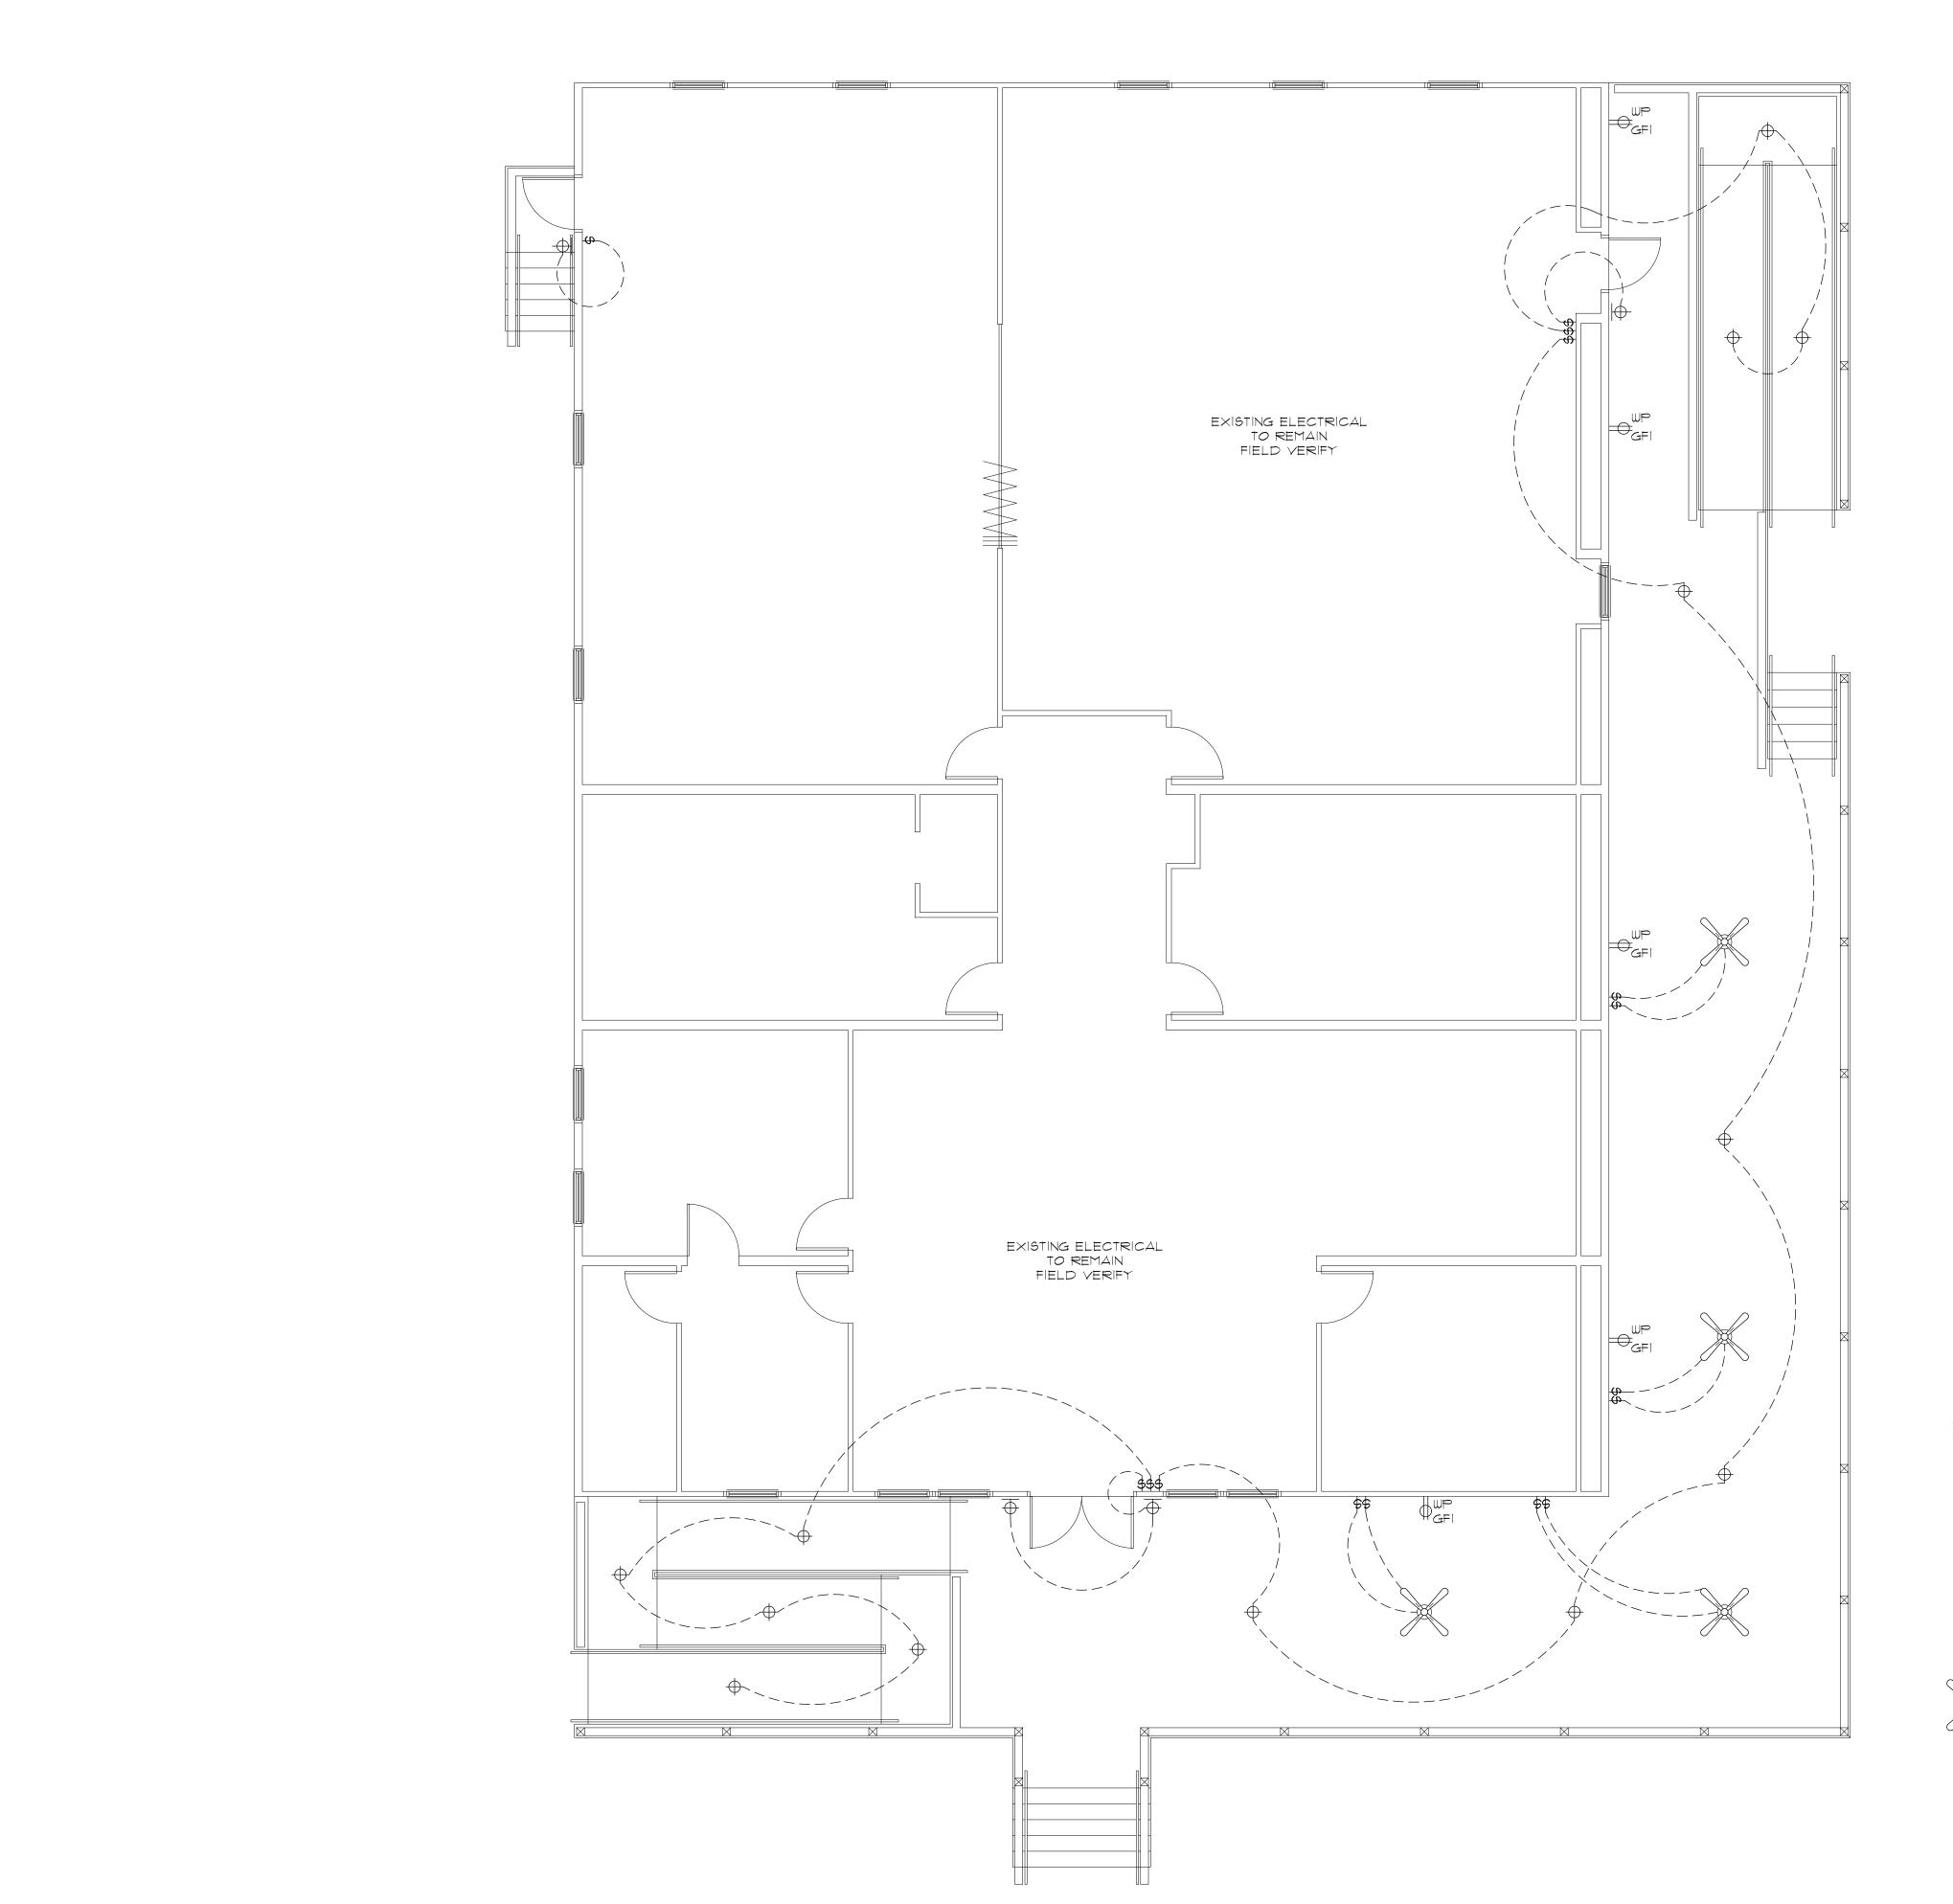

Electrical Legend

1207 WALL MOUNT DUPLEX RECEPTACLE 12" A.F.F. U.N.O.

WALL MTD LIGHT, SELECTED BY OWNER

CEILING MTD LIGHT, SELECTED BY OWNER

\$ WALL MOUNTED SWITCH - 48" A.F.F. U.N.O

GFI W/ GROUND FAULT INTERRUPTER

WP WEATHER PROTECTED

CEILING MTD FAN WITH LIGHT, SELECTED BY OWNER

Electrical Plan
3/6'=1'-0"

RDOVA ST ST AUGUSTINE FLORIDA 824

NEW PORCH
NEPTUNE BEACH, FLORIDA

Date: 4.29.22

Scale: AS NOTED

Drawn: MURPHY

File: NEPTUNE

SHEET